


LEGEND


ROAD RIGHT OF WAY LINE PROPERTY LINE ----- EDGE OF PAVEMENT — — — — — — — — EDGE OF GRAVEL ----- WOOD FENCE OHP OHP OHP OVERHEAD UTILITY LINE IRON ROD FOUND (DIA. , HT.) IRON PIPE FOUND (DIA. , HT.) UTILITY POLE ---- XXX ----- EXISTING 1' CONTOUR ---- XXX ---- EXISTING 5' CONTOUR EXIST. SEWER MANHOLE EXIST. CATCHBASIN EXIST. CURB STOP/WATER SHUT-OFF ----- W ------ WATER LINE (SIZE/TYPE NOT DETERMINED) — S — S — EXIST. SEWER MAIN ——— SS ———— SS — EXIST. SEWER SERVICE LINE ——— SD ——— SD — EXIST. STORMDRAIN LINE

1. THE PROPERTY LINE SHOWN HEREON ARE BASED ON A PLAN ENTITLED "TOTAL STATION SUBDIVISION SURVEY FOR THE JOHNSON LIBRARY TRUSTEES" DATED MAY 13, 2008 BY CARROL PETERS AS RECORDED IN MAP SLIDE 126 OF THE JOHNSON LAND RECORDS.

2. THE VERTICAL DATUM IS NAVD 1988 AS DETERMINED FROM CORRECTED, DUAL-FREQUENCY GPS OBSERVATIONS.

2. ATHE LOCATION OF UNDERGROUND UTILTIES ARE BASED ON MARKING BY THE TOWN OF JOHNSON, OCTOBER 2023 AND PLANS OF RECORD AND SHOULD BE CONSIDERED APPROXIMATE ONLY.

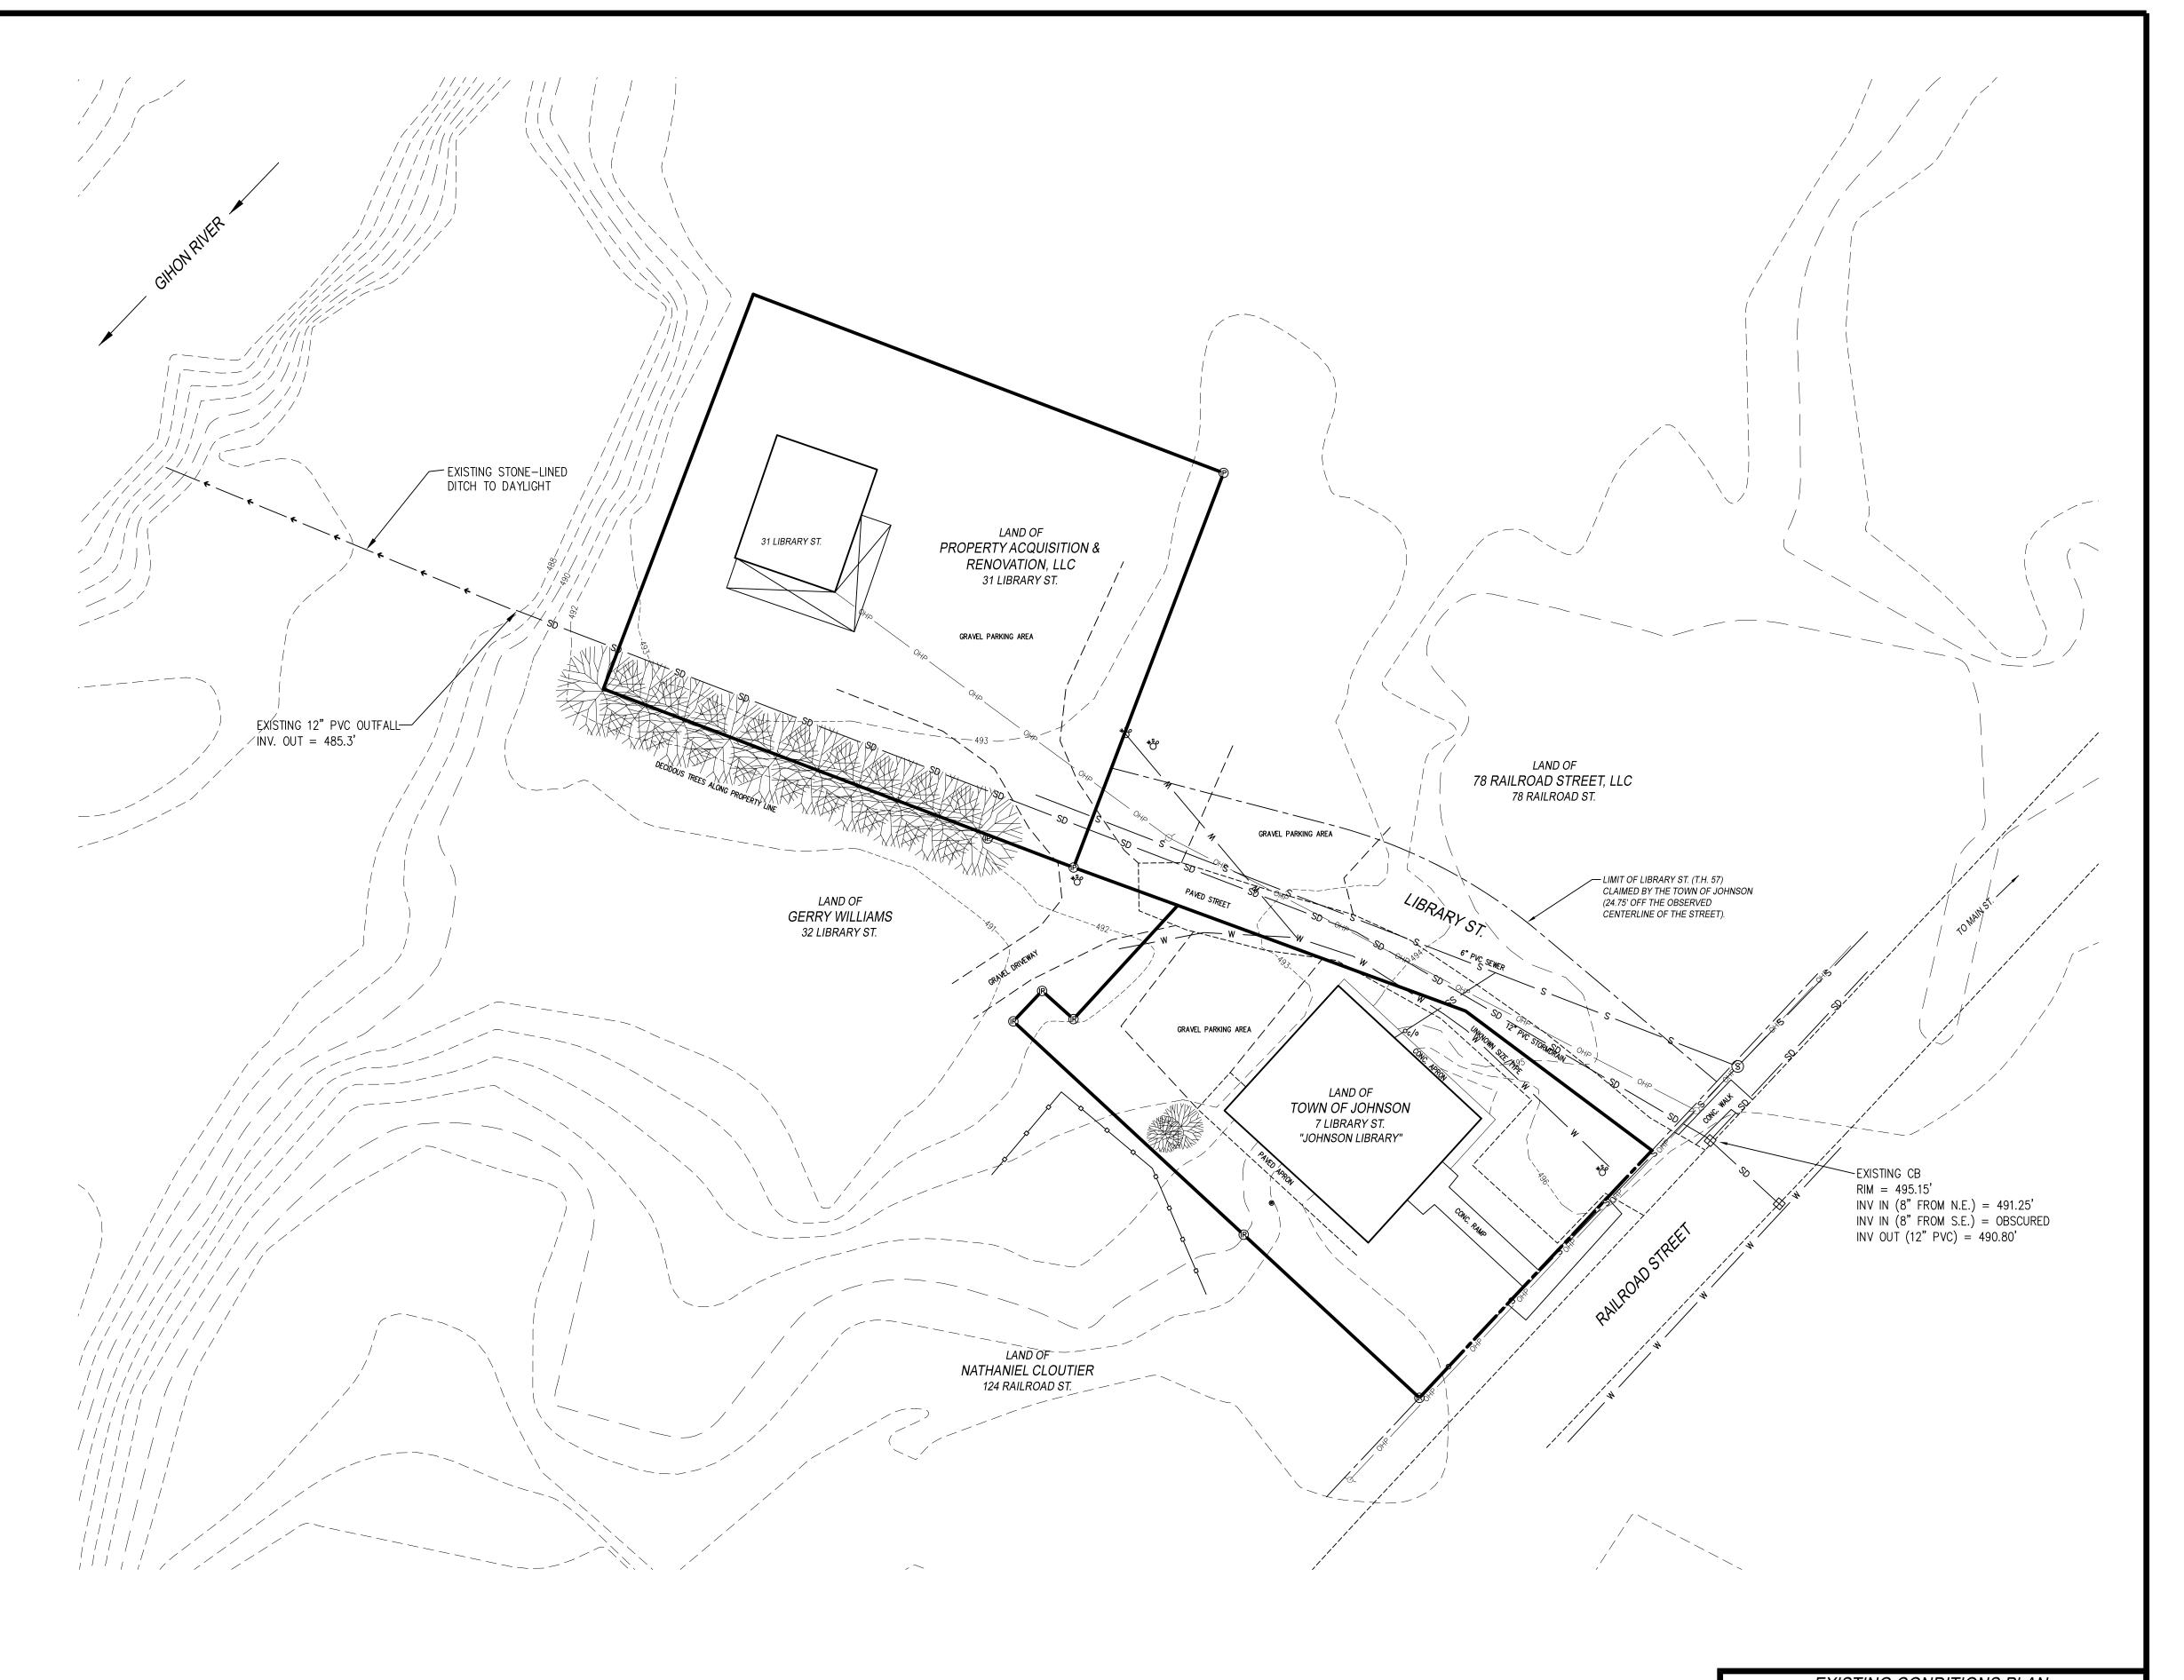

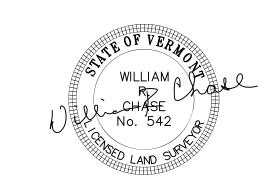

EXISTING CONDITIONS PLAN PROPOSED STORMWATER IMPROVEMENTS

TOWN LIBRARY

JOHNSON, VERMONT LIBRARY STREET

DRAWN BY:KKJ CHECKED BY:WRC FB/PG. EFB SHEET C1



GRAPHIC SCALE 1" = 20'



ROAD RIGHT OF WAY LINE PROPERTY LINE ---- EDGE OF PAVEMENT — — — — — — — — EDGE OF GRAVEL ----- WOOD FENCE OHP OHP OVERHEAD UTILITY LINE

LEGEND

IRON ROD FOUND (DIA. , HT.) IRON PIPE FOUND (DIA. , HT.) UTILITY POLE ---- XXX ----- EXISTING 1' CONTOUR

---- XXX ---- EXISTING 5' CONTOUR EXIST. SEWER MANHOLE EXIST. CATCHBASIN


EXIST. CURB STOP/WATER SHUT-OFF WATER LINE (SIZE/TYPE NOT DETERMINED) ———— S ———— S ——— EXIST. SEWER MAIN

——— SD ——— SD — EXIST. STORMDRAIN LINE

1. THE PROPERTY LINE SHOWN HEREON ARE BASED ON A PLAN ENTITLED "TOTAL STATION SUBDIVISION SURVEY FOR THE JOHNSON LIBRARY TRUSTEES" DATED MAY 13, 2008 BY CARROL PETERS AS RECORDED IN MAP SLIDE 126 OF THE JOHNSON LAND RECORDS.

2. THE VERTICAL DATUM IS NAVD 1988 AS DETERMINED FROM CORRECTED, DUAL-FREQUENCY GPS OBSERVATIONS.

2. ATHE LOCATION OF UNDERGROUND UTILTIES ARE BASED ON MARKING BY THE TOWN OF JOHNSON, OCTOBER 2023 AND PLANS OF RECORD AND SHOULD BE CONSIDERED APPROXIMATE ONLY.

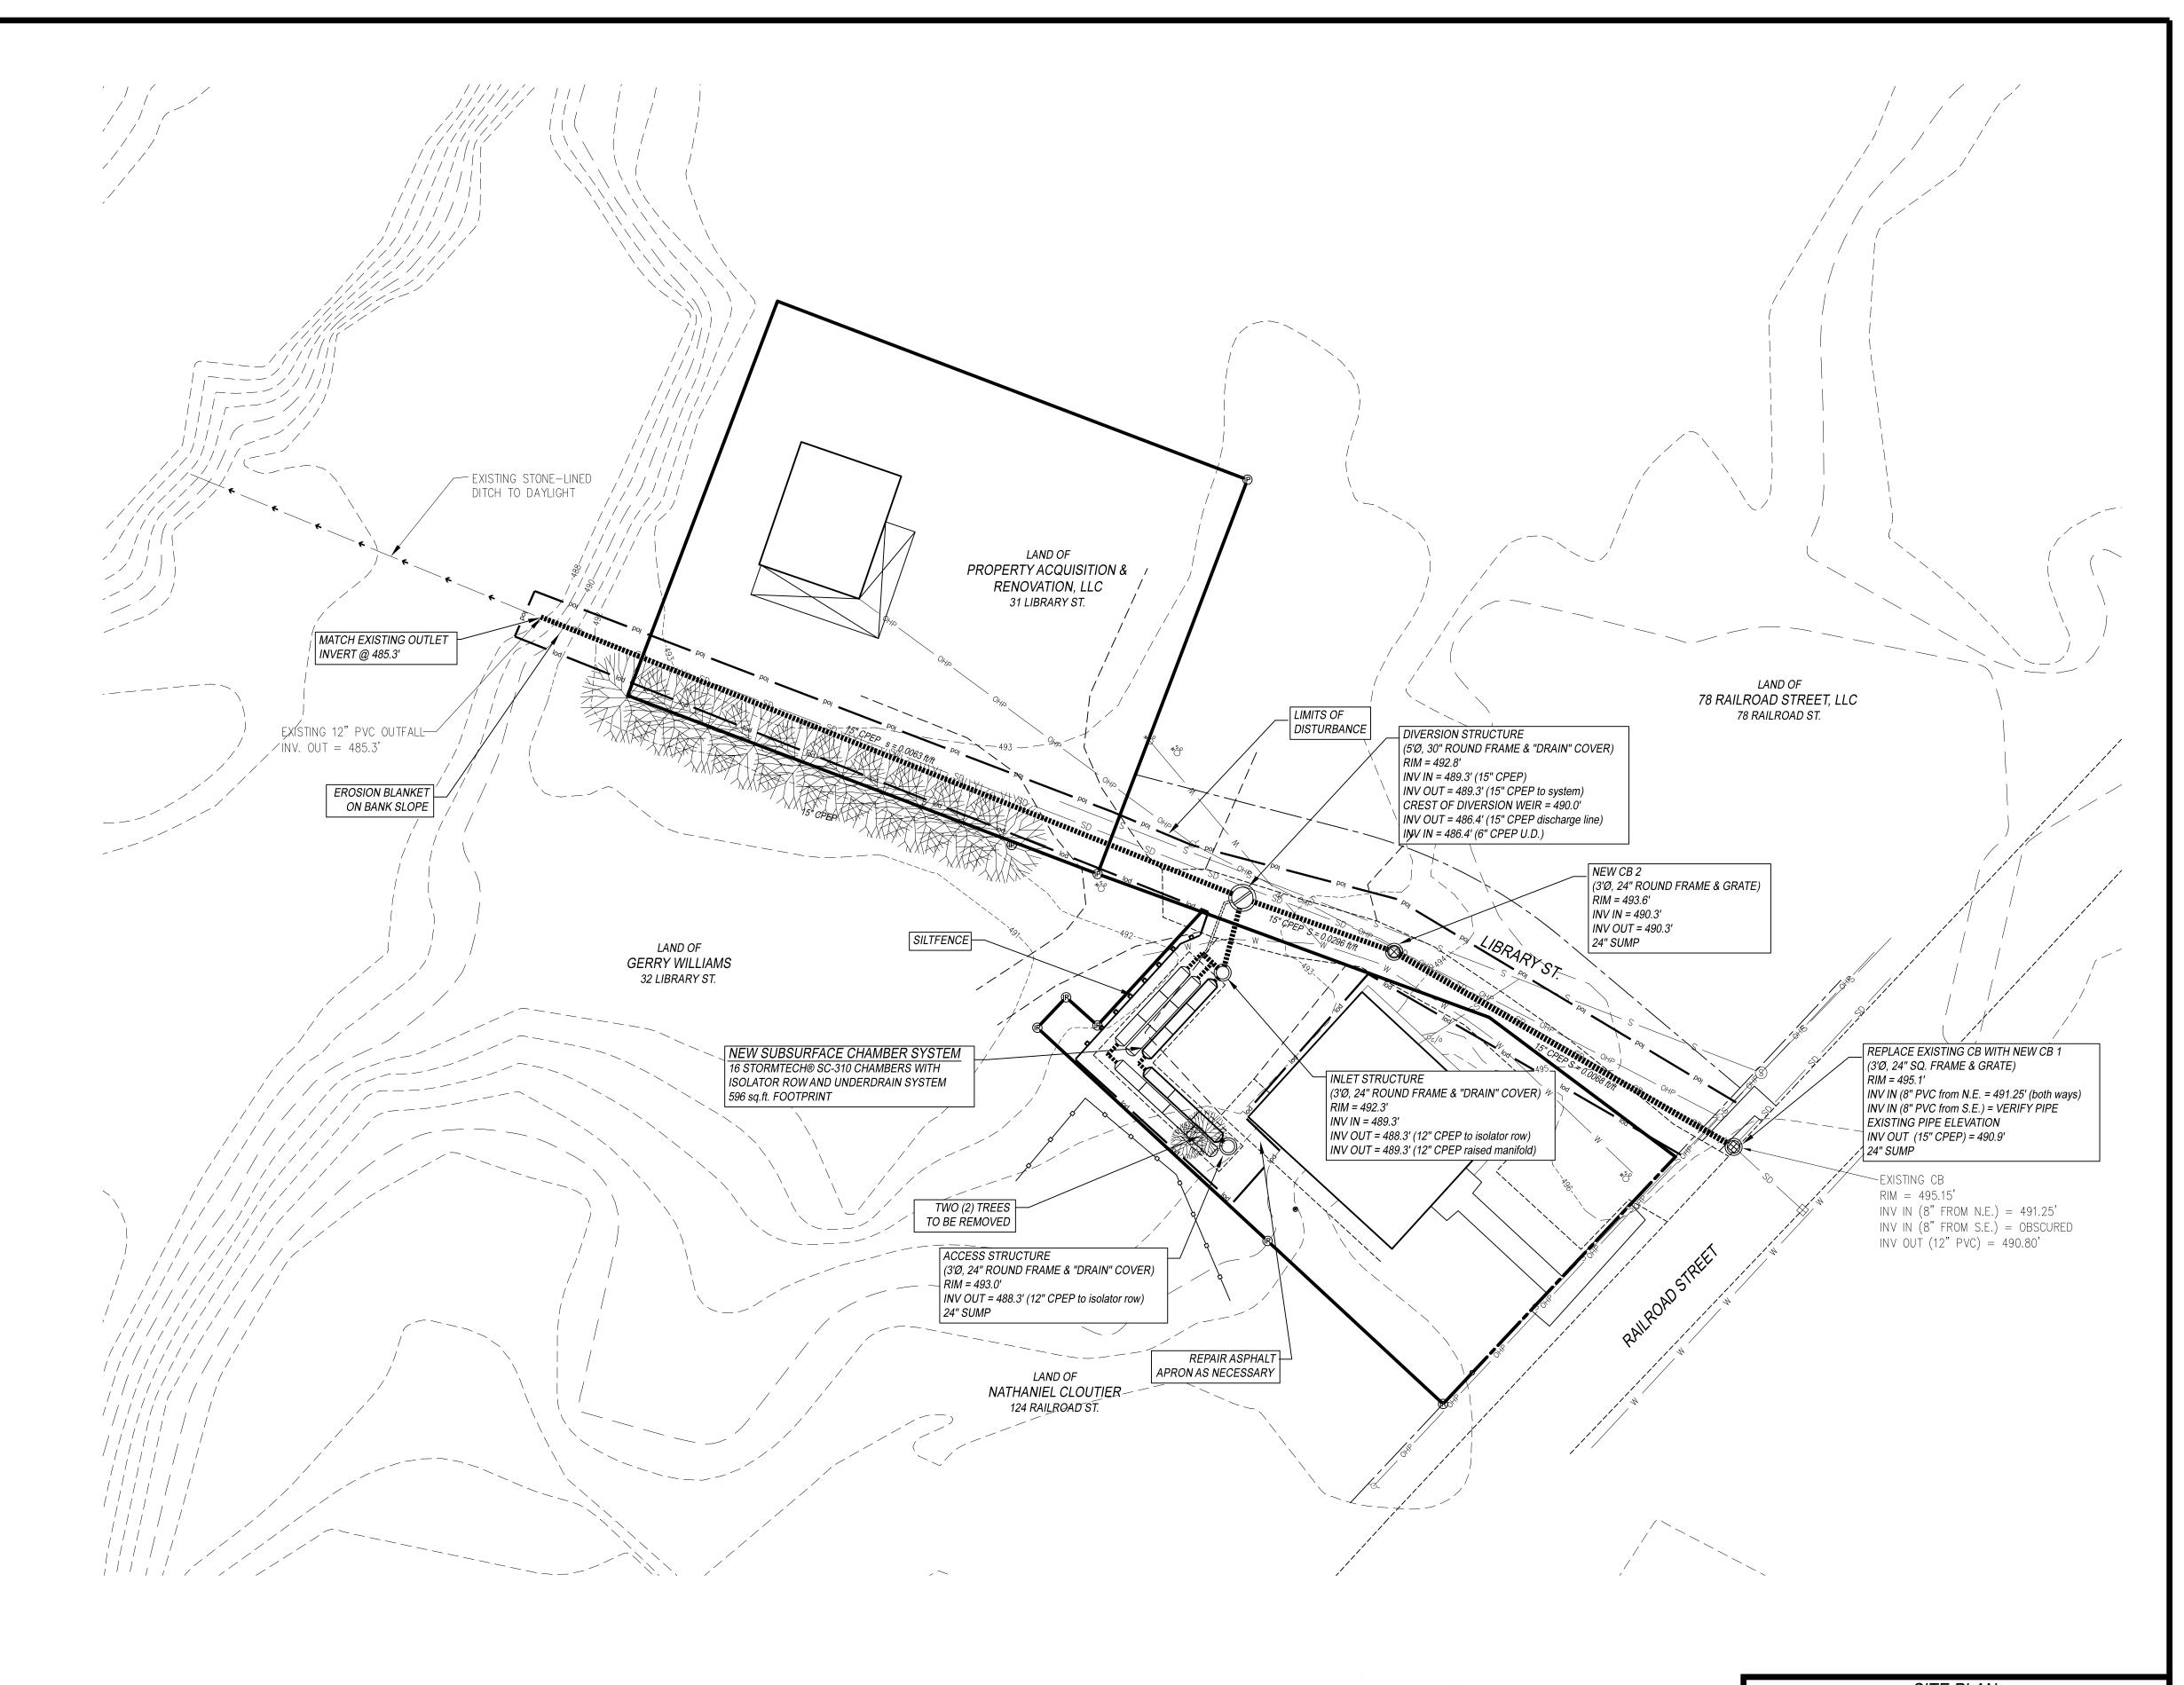



SITE PLAN PROPOSED STORMWATER IMPROVEMENTS

TOWN LIBRARY


LIBRARY STREET JOHNSON, VERMONT SCALE:1" = 20' DATE: 10/24/24 PROJ.# 23-134 DWG.# 0134B



PO BOX 4413, BURLINGTON, VT (802)497-2367

DRAWN BY: KKJ CHECKED BY: TC FB/PG. EFB SHEET C2

GRAPHIC SCALE 1" = 20'

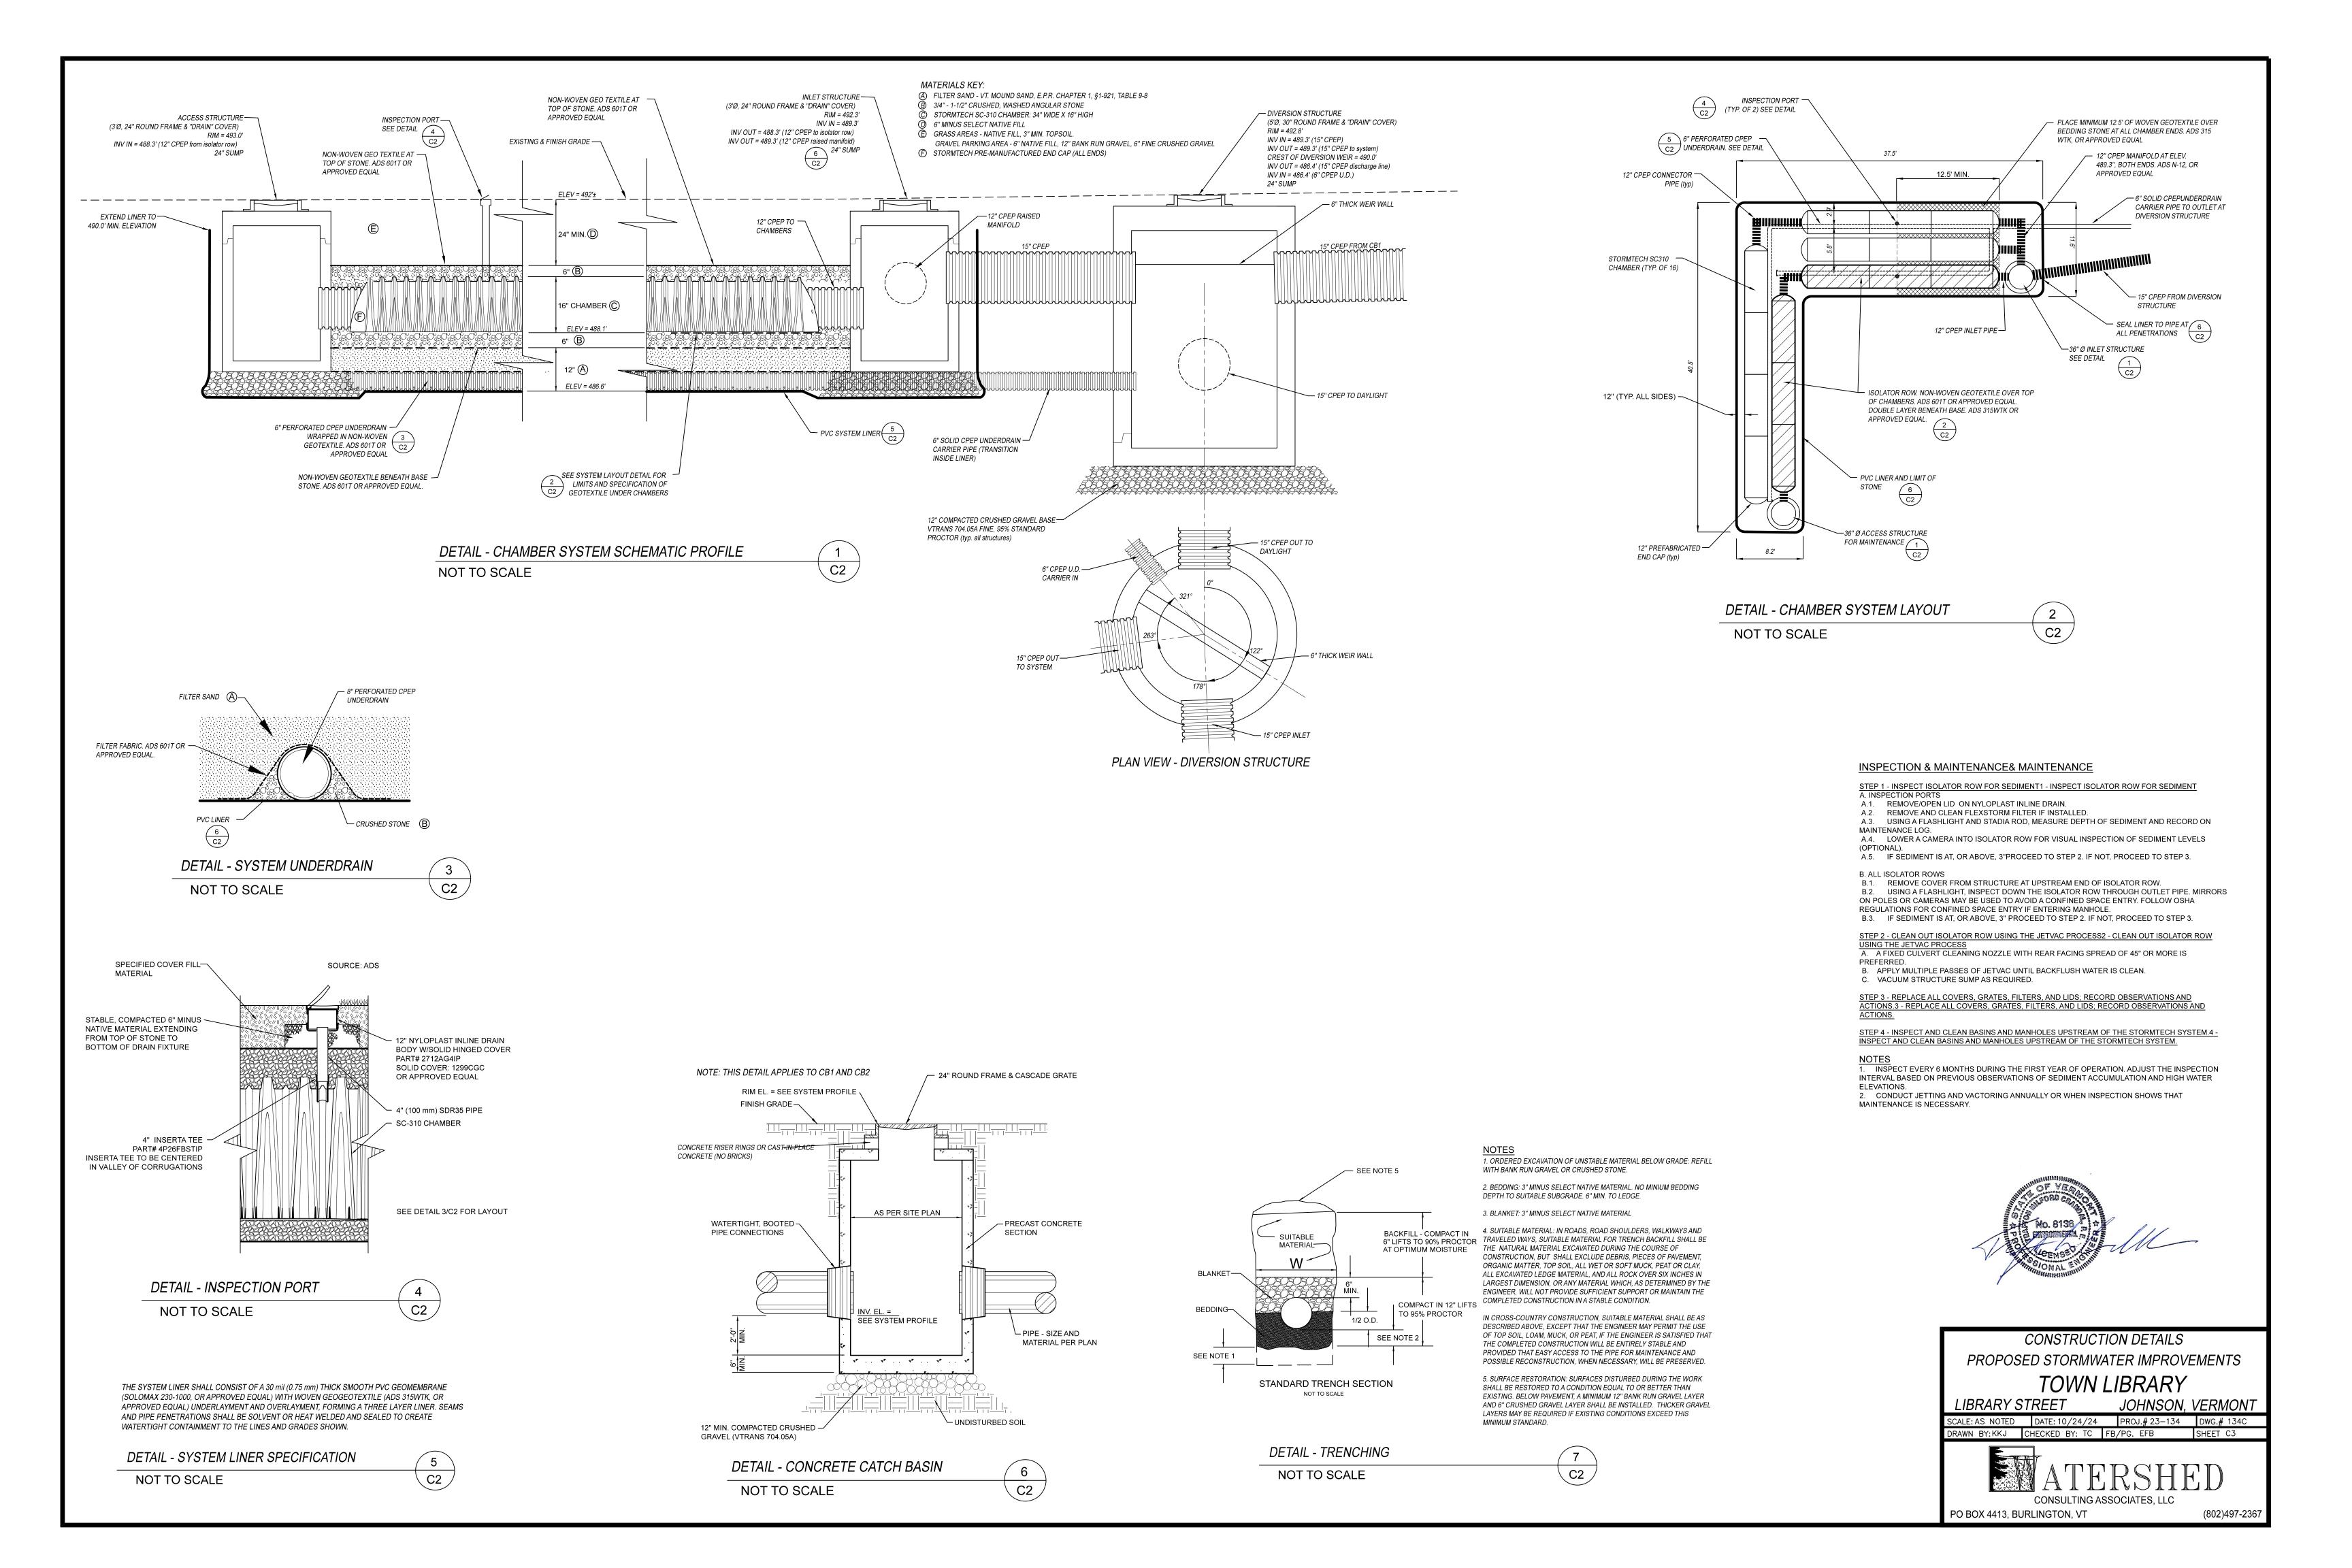

CONSTRUCTION SPECIFICATIONS

- 1. LIMIT OF DISTURBANCE CORDON SHALL BE 3-FOOT HIGH ORANGE "CONTRUCTION" SAFETY FENCE OR APPROVED EQUIVALENT, AND SHALL BE LOCATED AS SHOWN ON THE APPLICABLE PHASE PLAN.
- 2. SAID FENCE SHALL BE SUPPORTED BY STEEL 'U' OR 'T' TYPE POSTS PLACED AT MAXIMUM 16-FOOT INTERVALS.
- 3. FENCE SHALL BE WIRE OR "ZIP" TIED TO THE SUPPORT POSTS.
- 4. THE FENCE SHALL BE MAINTAINED IN A WORKMAN LIKE MANNER, AND SHALL REMAIN IN PLACE UNTIL FINAL SITE STABILIZATION IS ACHIEVED.

NOTE: WHERE SLOPES DO NOT EXCEED 3H:1V, MULCH MAY BE APPLIED IN

1. PREPARE SOIL BEFORE INSTALLING BLANKETS, INCLUDING ANY NECESSARY APPLICATION OF LIME, FERTILIZER, AND SEED.
NOTE: WHEN USING CELL-O-SEED DO NOT SEED PREPARED AREA. CELL-O-SEED MUST BE INSTALLED WITH PAPER SIDE DOWN.

WITH APPROXIMATELY 12" (30cm) OF BLANKET EXTENDED BEYOND THE UP-SLOPE PORTION OF THE TRENCH. ANCHOR THE BLANKET WITH A ROW OF STAPLES/STAKES APPROXIMATELY 12" (30 CM) APART IN THE BOTTOM OF THE TRENCH.

3 ROLL THE BLANKETS (A) DOWN OR (B.) HORIZONTALLY ACROSS THE SLOPE. BLANKETS WILL UNROLL WITH APPROPRIATE SIDE. AGAINST THE SOIL SURFACE. ALL BLANKETS MUST BE SECURELY FASTENED TO SOIL SURFACE BY PLACING STAPLES/STAKES IN APPROPRIATE LOCATIONS AS SHOWN IN THE STAPLE PATTERN GUIDE. WHEN USING THE DOT SYSTEM, STAPLES/ŠTAKES

SHOULD BE PLACED THROUGH EACH OF THE COLORED DOTS CORRESPONDING TO THE APPROPRIATE STAPLE PATTERN. 4. THE EDGES OF PARALLEL BLANKETS MUST BE STAPLED WITH APPROXIMATELY 2" - 5" (5 CM - 12.5 CM) OVERLAP DEPENDING

3" (7.5 CM) OVERLAP. STAPLE THROUGH OVERLAPPED AREA, APPROXIMATELY 12" (30 CM) APART ACROSS ENTIRE

DETAIL - EROSION CONTROL BLANKET - SLOPE INSTALL

NOT TO SCALE

5. CONSECUTIVE BLANKETS SPLICED DOWN THE SLOPE MUST BE PLACED END OVER END (SHINGLE STYLE) WITH AN APPROXIMATE

*IN LOOSE SOIL CONDITIONS, THE USE OF STAPLE OR STAKE LENGTHS GREATER THAN 6" (15 CM) MAY BE NECESSARY TO

BACKFILL AND COMPACT THE TRENCH AFTER STAPLING. APPLY SED ON OF STAPLED SOIL AND FOLD REMAINING 12" (30 CM)
PORTION OF BLANKET BACK OVER SEED AND COMPACTED SOIL. SECURE BLANKET OVER COMPACTED SOIL WITH A ROW OF
STAPLES/STAKES SPACED APPROXIMATELY 12" (30 CM) APART ACROSS THE WIDTH OF THE BLANKET.


2. BEGIN AT THE TOP OF THE SLOPE BY ANCHORING THE BLANKET IN A 6" (15 CM) DEEP X 6" (15 CM) WIDE TRENCH

LIEU OF EROSION PREVENTION BLANKET

C3 /

DETAIL - LIMITS OF DISTURBANCE CORDON

NOT TO SCALE

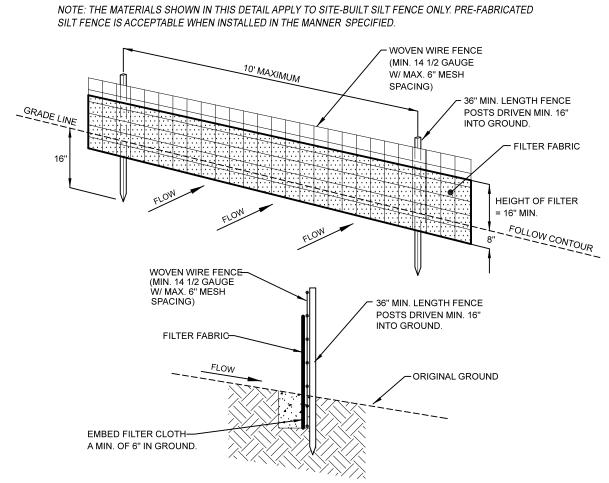


CONSTRUCTION SPECIFICATIONS

- 1. WOVEN WIRE FENCE TO BE FASTENED SECURELY TO FENCE POSTS WITH WIRE TIES OR STAPLES. POSTS SHALL BE STEEL EITHER "T" OR "U" TYPE OR HARDWOOD.
- 2. FILTER CLOTH TO BE TO BE FASTENED SECURELY TO WOVEN WIRE FENCE WITH TIES SPACED EVERY 24" AT TOP AND MID SECTION. FENCE SHALL BE WOVEN WIRE, 12 1/2 GAUGE, 6" MAXIMUM MESH OPENING.
- 3. WHEN TWO SECTIONS OF FILTER CLOTH ADJOIN EACH OTHER THEY SHALL BE OVER-LAPPED BY SIX INCHES AND FOLDED. FILTER CLOTH SHALL BE EITHER FILTER X, MIRAFI 100X, STABILINKA T140N, OR APPROVED EQUIVALENT.
- 4. PREFABRICATED UNITS SHALL BE GEOFAB, ENVIROFENCE, OR APPROVED EQUIVALENT. 5. MAINTENANCE SHALL BE PERFORMED AS NEEDED AND MATERIAL REMOVED WHEN "BULGES" DEVELOP IN THE SILT FENCE.

DETAIL - SILT FENCE NOT TO SCALE

C3

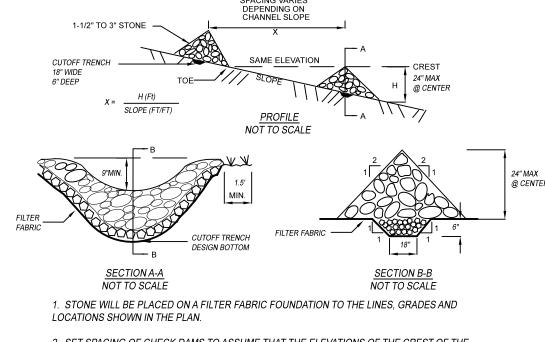


- 2. SET SPACING OF CHECK DAMS TO ASSUME THAT THE ELEVATIONS OF THE CREST OF THE DOWNSTREAM DAM IS AT THE SAME ELEVATION OF THE TOE OF THE UPSTEARM DAM. 3. EXTEND THE STONE A MINIMUM OF 1.5 FEET BEYOND THE DITCH BANKS TO PREVENT CUTTING AROUND THE DAM.
- 4. PROTECT THE CHANNEL DOWNSTREAM OF THE LOWEST CHECK DAM FROM SCOUR AND EROSION WITH STONE OR LINER AS APPROPRIATE.
- 5. ENSURE THAT CHANNEL APPURTENANCES SUCH AS CULVERT ENTRANCES BELOW CHECK DAMS ARE NOT SUBJECT TO DAMAGE OR BLOCKAGE FROM DISPLACED STONE. MAXIMUM DRAINAGE AREA 2 ACRES.

DETAIL - TEMPORARY STONE CHECK DAM

NOT TO SCALE



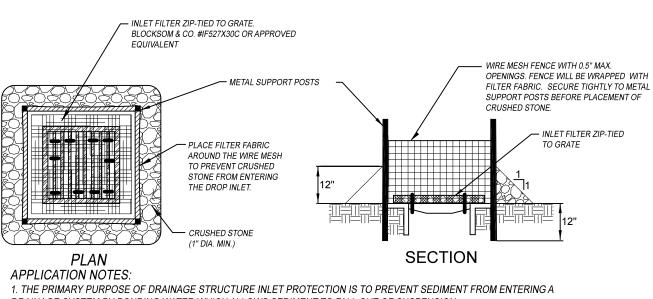

DRAINAGE SYSTEM BY PONDING WATER WHICH ALLOWS SEDIMENT TO FALL OUT OF SUSPENSION. 2. THESE EXAMPLES OF DROP INLET PROTECTION ARE NOT INTENDED FOR USE ON GRADES. ON GRADE THEY MAY

CAUSE WATER TO BYPASS THE STRUCTURE, CREATING ADDITIONAL EROSION OR FLOODING. 3. POSSIBLE MODIFICATIONS FOR USE ON GRADE INCLUDE ADDING A BERM DOWNSTREAM OF THE INLET TO CREATE

PONDING. CHECK DAMS MAY ALSO BE USED UPSTREAM OF THE INLET TO SLOW VELOCITIES. 4. PREFABRICATED DROP INLET PROTECTION SPECIFICATIONS SHALL BE PROVIDED TO THE ENGINEER FOR APPROVAL PRIOR TO USE.

DETAIL - ROCK BARRIER INLET PROTECTION

NOT TO SCALE



EROSION CONTROL NOTES

TOTAL PROJECT DISTURBED AREA IS 8000 SQ.FT. THEREFORE NO CONSTRUCTION GENERAL PERMIT IS REQUIRED.THE PROJECT SHALL BE EXECUTED IN CONFORMANCE WITH THE REQUIREMENTS OF THE STATE OF VERMONT "LOW-RISK SITE HANDBOOK FOR EROSION PREVENTION AND SEDIMENT CONTROL" (2020). THE CONTRACTOR SHALL INSTALL ALL MEASURES NECESSARY AS DICTATED BY THE WORKPLAN AND/OR WEATHER EVENTS. THE CONTRACTOR SHALL BE RESPONSIBLE FOR PREVENTING SEDIMENT FROM LEAVING THE SITE.

- 1. CONTRACTOR SHALL INSTALL AND MAINTAIN ALL APPROPRIATE EROSION CONTROL MEASURES AS DICTATED BY THE STATE OF VERMONT "LOW-RISK SITE HANDBOOK FOR EROSION PREVENTION AND SEDIMENT CONTROL", EFFECTIVE AUGUST 2020. REFER TO THE HANDBOOK, MANUFACTURERS SPECIFICATIONS AND THIS SHEET FOR DETAILS REGARDING THE IMPLEMENTATION OF THESE MEASURES.
- 2. THE EROSION PREVENTION MEASURES SHOWN ON THIS PLAN, REPRESENT THE MINIMUM NECESSARY IN GOOD WEATHER CONDITIONS WITH A PROPERLY RUN SITE. THE CONTRACTOR SHALL BE RESPONSIBLE FOR PREVENTING SEDIMENT FROM LEAVING THE SITE AND SHALL EMPLOY WHATEVER ADDITIONAL MEASURES ARE NECESSARY TO ACCOMMODATE THEIR WORK PLAN AND CHANGING WEATHER CONDITIONS.
- 3. ALL AREAS MUST HAVE TEMPORARY OR PERMANENT STABILIZATION WITHIN 14 DAYS OF INITIAL DISTURBANCE. AFTER THIS TIME ANY DISTURBANCE IN THE AREA MUST BE STABILIZED AT THE END EACH WORK DAY.
- 4. ALL EROSION CONTROL MEASURES MUST BE INSPECTED AT A FREQUENCY OF EVERY 7 DAYS OR WITHIN 24 HOURS OF A PRECIPITATION EVENT SUFFICIENT TO CAUSE RUNOFF TO LEAVE THE SITE. ALL DAMAGED MEASURES SHALL BE REPLACED OR REPAIRED AS NECESSARY.
- 5. MATERIAL MOVED OFF-SITE SHALL BE SUBJECT TO THE SAME EROSION PREVENTION REQUIREMENTS AS ON-SITE MATERIALS. PLACE IN AN UPLAND LOCATION, SURROUND WITH SILT FENCE, MULCH AND SEED IF NOT TO BE UNDISTURBED FOR MORE THAN 14 DAYS.
- 6. ANY DEWATERING ACTIVITIES MUST DISCHARGE ONTO A STABLE VEGETATED SURFACE, INCORPORATE APPROPRIATE SEDIMENT REMOVAL MEASURES, AND DISCHARGE IN A LOCATION WHERE FLOW WILL NOT REINCORPORATE WITH DISTURBED AREAS.

SPECIFIC MEASURES:

1. THE LIMITS OF THE AREA TO BE DISTURBED SHALL BE SURROUNDED WITH CORDON OR SILT FENCE.

- 2. SILT FENCE SHALL BE INSTALLED AT THE DOWNSLOPE LIMITS OF THE PROPOSED DISTURBANCE AND PLACED SO AS NOT TO CONCENTRATE RUNOFF.
- 3. STONE INLET/OUTFALL PROTECTION SHALL BE INSTALLED IN CONJUNCTION WITH STORMWATER PRACTICES.
- 4. AT PROJECT COMPLETION, DISTURBED SLOPES IN EXCESS OF 3H:1V SHALL HAVE EROSION PREVENTION BLANKET INSTALLED PER MANUFACTURUES SPECIFCATIONS AND BE "TRACKED" IN PLACE WITH A CLEATED MACHINE .
- 5. AT PROJECT COMPLETION, ALL NEW OR DISTURBED CHANNELS SHALL HAVE EROSION PREVENTION BLANKET INSTALLED PER MANUFACTURES SPECIFICATIONS.

STABILIZATION NOTES

- 1. HAY MULCH SHALL BE APPLIED TO ALL DISTURBED AREAS AT 2 TONS PER ACRE.
- 2. SOIL MATERIAL PILES SHALL BE MULCHED AND RINGED WITH SILT FENCE.
- 3. DISTURBED SOILS TO BE STABIZLED AS FOLLOWS:

CHANNEL SLOPE NORTH AMERICAN GREEN S150BN

SIDE SLOPE

HAY MULCH ONLY < 3:1 NORTH AMERICAN GREEN S150BN OR EQUAL = or > 3:1

(NOTE: NO SLOPES GREATER THAN 2:1 ARE PROPOSED)

- LIME MAY BE APPLIED TO ACHIEVE SOIL Ph OF 6.5 FOR AREAS TO BE SEEDED.
- APPLY PHOSPHOROUS-FREE COMMERCIAL FERTILIZER AT 1.0 LBS/1,000 S.F. IF REQUIRED.
- LIME AND FERTILIZER SHALL BE MIXED THOROUGHLY INTO THE SEEDBED DURING SOIL PREPARATION.
- ALL DISTURBED AREA SHALL HAVE A MIN. OF 3" OF TOPSOIL PRIOR TO SEEDING.
- SEED MIX: SEED MIX FOR TEMPORARY AND PERMANENT STABLIZATION SHALL BE VTRANS RURAL CONSERVATION MIX AND BE CLEAN MATERIALS GUARANTEED TO BE 95% FREE OF SEEDS OTHER THAN THOSE LISTED:

<u>% BY WEIGHT</u> CREEPING RED FESCUE 35%

TURF-TYPE TALL FESCUE *25%* KENTUCKY BLUE GRASS 10% TURF-TYPE PERENNIAL RYEGRASS 12% ANNUAL RYE GRASS 15%

WHITE CLOVER 3%

EROSION CONTROL DETAILS PROPOSED STORMWATER IMPROVEMENTS **TOWN LIBRARY**

LIBRARY STREET JOHNSON, VERMONT SCALE: AS NOTED DATE: 10/24/24 PROJ.# 23-134 DWG.# 134D

DRAWN BY:KKJ CHECKED BY: TC FB/PG. EFB SHEET C4



PO BOX 4413. BURLINGTON. VT

(802)497-2367

